

OIL & GAS DEVELOPMENT COMPANY LIMITED PROCUREMENT DEPARTMENT (LOCAL), ISLAMABAD SCHEDULE OF REQUIREMENT

Material :SUPPLY & INSTALLATION OF STEEL STRUCTURE PLATFORM WITH 5-TON MANUAL GANTRY CRANE AT UCH PLANT LIMITED

Bid Bond Value : RS.180.000/-

Due Date:

Tender Enquiry No: PROC/LF/PT/17749/19

EVALUATION WILL BE CARRIED OUT ON FULL

Attachment(if any) : YES

Sr No	Description	Quantity	Make/Brand offered	Unit	Unit Price (PKR) Inclusive Of All Taxes Except GST	Unit Price (PKR) Inclusive of GST	Total Price (PKR) Inclusive of GST	Delivery Period Offered	deviation from Tender Spec. If Any
5	SUPPLY & INSTALLATION OF STEEL STRUCTURE PLATFORM WITH 5-TON MANUAL GANTRY CRANE AT UPL FOR OGDCL AS PER ATTACHED TOR.	1		Number					

Special Note: The prospective bidders also download the master set of Tender Document

The prospective bidders may keep in touch with OGDCL web site for downloading the clarifications/amendments (if any) issued by OGDCL.
 PAYMENT TERMS IS 100% AFTER DELIVERY, INSTALLATION & COMMISSIONING OF PLATFORM & CRANE AT UCH PLANT LIMITED DELIVERY, INSTALLATION, ERECTION, COMMISSIONING IN 04 MONTHS ON FOR UCH PLANT LIMITED, BALOCHISTAN. BID VALIDITY 120 DAYS FROM TECHNICAL BID OPENING.

Discount (if any) shall only be entertained on Schedule of Requirement of Bidding Document (Financial Proposal). If the discount is mentioned elsewhere in the bid, the same shall not be entertained.



OIL & GAS DEVELOPMENT COMPANY LIMITED PROCUREMENT DEPARTMENT (LOCAL), ISLAMABAD SCHEDULE OF REQUIREMENT

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Mandatory Checklist

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lease confirm the compliance of the following manualory	Documents To be Attached with the Technical/Financial Bids				
	Technical Bid	Yes		No	
riginal Bid Bond	Technical Bid	Yes	·	No	
ppy of NTN Certificate				- <u>-</u>	
opy of GST Certificate	Technical Bid				
onfirmation that the Firm is appearing on FBR's Active Taxpayer	Technical Bid	Yes		No	
ist		Yes		No	
ouly signed and stamped Annexure-A (Un-priced)	Technical Bid	Yes		No	[]
Duly filled, signed and stamped Annexure-B		Yes		No	
Duly filled, signed and stamped Annexure-D	Technical Bid				·- · ·
Duly filled, signed and stamped Annexure-L on Company's	Technical Bid	Yes		No	
etterhead	Technical Bid	Yes	[]	No	[]
Duly signed and stamped Annexure-M on Company's Letterhead Duly signed and stamped Annexure-N on Non-Judicial Stamp		Yes	[]]	No	[_]
Paper duly attested by Notary Public	Financial Bid	Yes		No	[_]
Duly filled, signed and stamped Annexure-A (Priced)		Yes		No	
Duly filled, signed and stamped Annexure-C	Financial Bid				[]
Duly filled, signed and stamped Annexure-E	Financial Bid	Yes	لاا 		لــــــــــــــــــــــــــــــــــــ



OIL & GAS DEVELOPMENT COMPANY LIMITED PROCUREMENT DEPARTMENT (LOCAL), ISLAMABAD SCHEDULE OF REQUIREMENT

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For the Vendors/Contractors who opt to submit Bank Draft/Call Deposit/Pay order against Bid Bond/Performance Bond, our Accounts Department has finalized an arrangement for online payment to such Vendors/Contractors, which will be processed through (IBFT & LFT) for which following information is required:

	IBAN No. (International Bank Account Number 24 Digits)
	Vendor Name as per Title of their Bank Account
	Contact No.of Company's CEO/ Owner (Mobile & Landline)
iv.	Bank Name.
V.	Bank Branch Name and Code

Name, Sign and Stamp of the authorized official of the Bidder(s)



OIL & GAS DEVELOPMENT COMPANY LIMITED UCH GAS FIELD



SCOPE OF WORK

Subject: Installation of Platform and 05 Ton Manual Gantry Crane for <u>4rth Filter Vessel at Uch Power Limited (UPL) for OGDCL</u>

- 1- Supply of pre-fabricated / fabricated/ vendor supplied and site installation / erection of steel structure platform as specified in drawings.
- 2- Sand blasting, primer application and finish coating as specified in BOQ along with material.
- 3- Supply and installation of 01 No. manually operated 05 Ton overhead Gantry crane as specified in BOQ.
- 4- Third party inspection (TPI) of the fabricated structure at contractor's workshop from OGDCL approved TPI companies at pre-shipment stage and construction, at ogDCL cost.
- 5- Transportation of all material (Civil & steel structure) to Uch Power Limited (UPL) site near Dera Murad Jamali, Balochistan.
 - 6- Shifting, loading and unloading of the material, tools, equipment etc.
 - 7- Proper Stacking/storing of the material near work site and providing proper cover to safeguard from weather effects.
 - 8- Manual Excavation and construction of 06 No. civil foundations along with material, as specified in drawings and BOQ.
 - 9- Shifting/disposal of the excavated earth material as to be advised by M/s UPL/OGDCL.



10- Installation/Erection of the platform structure.

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- 11- Finish coating of the steel structure along with material, as specified in BOQ.
- 12- Testing and Commission of Gantry Crane.
- 13- Proper housekeeping of the worksite up to the satisfaction of M/s OGDCL / UPL.

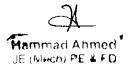


www.Inspection-for-Industry.com

Document Name:

Contractor Quality Control Plan for Steel Structure Construction

No.	Item descrip	tion	cc	TPI	Owner
2.	Steel structure items				
2.1	Erection of structural steel				
2.1.1	Pre-installation check				
	1) Foundation and ancho	or bolts			
	- Final dimension				
	 Visual check 				
	2) Welding				
	 Welding procedure sp 	ecs.			
	- Welder performance of	ualification test			
	- Proper fit-up, appeara	ince and size of			
	weld				
	3) Visual checks		1.1	. 1	221
	 Shape and size 		Н	~	vv
	 Contact surface of joir 	it and ensure			
	 Sharp comers and but 	rs are removed			
	- Where Hi-strength bo	Its are required,			
	ensure that they are b	eing used			
	 Base plates square with the second sec	th column			
	 Bolts or fasteners 				
	- Shop erected to	assure fit up			
	(optional)				
	4) Identification of t	agging, piece			
	marking and match m	arking			
2.1.2	Erection of structural				
	1) Visual check				
	 Straighten the anchor 	bolts and clean			
	threads				
	Leveling plate or group	ut pads in place			
	and grouted				
	- Anchor bolts size & s		Н	W	
	against column base - Bolts double-nutted	piate			
	- Bolt tightening				
	- Installing bracing				
	2) Orientation				
	 Location and position 				



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Document Name:

Contractor Quality Control Plan for Steel Structure Construction

	4) Dimension			
	- Eccentricity			
	- Base plate height and ele	vation		
	- Tilt			
	- Column & beam for p	olumb level,		
	alignment and flamess			
	- Sweep			
2.1.3	High strength bolting			
	1) Torque control	l H	W	1
	2) Tightening high strength I	polts		••
2.1.4	Welding			
	1) Welds for size, length a	nd stands of		
	workmanship			
	- Contour and appearance	e of the weld		
	surface	н		
	 Surface defects 		V N	•••
	- Craters, undercutting	overlapping		
	edges of welds			
	- Cracks, etc.			
	2) Visual check			
2.2	Fireproofing of structural steel			
2.2.1	1) Cast-in-place concrete			
	Preparation of steel surface	ce		
	Certificate of cement			
	 Coarse aggregate 	H	\sim	$ $ \sim
	5) Slump test			
	6) Strength			
	7) Thickness			
2.2.2	Cement mortar			
	 Preparation of steel surface 	ace		
	2) Certificate of cement			
	3) Sand	Н	W	
	4) Fixing of metal lath			
	5) Curing			
	6) Thickness			



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Document Name:

Contractor Quality Control Plan for Steel Structure Construction

2.2.3	Lightweight mortar 1) Preparation of steel surface 2) Fixing of metal lath 3) 3) Thickness	Н	\sim	\sim
2.2.4	Preformed board 1) Preparation of steel surface 2) Installation of performed board 3) Joint of board	н	W	\sim
2.3	 Painting of structural steel 1) Hot dip galvanized 2) Other that above 1) 3) (Refer to the section 9 painting) 	н	W	W

CC: Construction Contractor

TPI: Third Party Inspection

H: Hold Point; Hold on the production till TPI Inspector performs inspection and supervise the required test

If you want to use this draft for inspection and test plan you need to fill the TPI and Owner Column based your project requirement. You may use following abbreviation for filling the columns:

W: Witness Point; Manufacture shall notify client and TPI Inspector but there is no hold on the Construction;

R: Document Review; Review means Review document, which includes of material test certificates, test reports, records and etc.

A: Approval

SW: Spot Witness; for items with spot witness contractor shall notify TPI inspector as fulfilling the monitoring;





UCH GAS FIELD



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GENERAL TERMS & CONDITIONS

Subject: <u>Installation of Platform and 05 Ton Manual Gantry Crane for</u> <u>4rth Filter Vessel at Uch Power Limited (UPL) for OGDCL</u>

Contractor's Responsibilities:

- 1- Permit to work and HSEQ policy compliance to OGDCL and UPL (UCH Power Limited). (Certification and QA/QC documents to be attached)
- 2- Resources and personnel certification for working inside UPL
- 3- Last and previous work history at UPL. List of jobs carried out at UPL to be attached.
- 4- Last 5 years job list in E&P / oil & gas sector (upstream) and refining (downstream) to be provided.
- 5- Turnover of over Rs. 15 million in each of the last five years to be the mandatory criteria. List of jobs for this value must be provide for last 5 years.
- 6- Submission of manufacturing plan/schedule.
- 7- Submission of QA/QC plan with inspection guidelines for the Client.
- 8- Pakistan Engineering Council (PEC) category C-3 valid certification of the contractor is mandatory and copy of the certificate to be attached.



9- Qualification of the contractor will be evaluated as per below criteria:

Sr. #	ITEM	Max. Marks	Marks obtained
1	Scope compliance	30	
2	PEC C3 certificate valid copy	10	
3	UPL job history (one job 2 marks)	15	
4	Company job history with E&P company	15	
5	Job Schedule	15	
6	Financial Health (turnover of 15 million per year): Three years verified Beneficiary Company's Bank Account	15	

- 10- Hot job (welding/cutting/grinding) will not be allowed at UPL site for installation of platform.
- 11- All the structure will be pre-fabricated at contractor's workshop and will be erected at site through nut bolts.
- 12- OGDCL engineer will inspect all the pre-fabricated structure at the contractor's workshop before supply at UPL site.
- 13- Sand blasting and primer application of the structure will be carried at contractor's workshop as per BOQ specifications.
- 14- Contractor has to arrange all the necessary tools, machinery, scaffolding and whatever material required for the completion/execution of job.
- 15- Contractor will safeguard the isolated area of vertical vessel up to full height so that to avoid falling of the platform structure on nearby high pressure live lines during erection job.
- 16- All lifting equipment/machinery along with operators to be used during erection at UPL site should have valid third party LEEA certification. i.e. Crane, Shackles, Lifting Belts, Chain blocks, Safety harnesses etc.
- 17- For 05 tons overhead gantry Crane, 1) Make 2) Model and 3) Country of origin to be approved from OGDCL and Crane must be certified. Details as above must be provided with the bid.



- 18- For manual gantry Crane to be installed, Lifting Equipment Engineers Association (LEEA) certification must be provided.
- 19- All kind of transportation including shifting of material, tools, equipment, working crew "to" and "from" the worksite, pick & drop of crew etc will be the responsibility of the contractor.
- 20- Site In-charge to be deployed by the contractor to supervise the whole job.
- 21- One HSE supervisor will also be deputed at site by the contractor.
- 22- Tools to be used for nut bolts tightening must be non-sparking i.e. Brass hammers for Steel striking spanners OR torque wrench should be used.
- 23- Contractor has to submit detailed "Method Statement/Job execution plan" for the whole job before mobilization to UPL site.
- 24- Contractor has to fulfill all the documentation, HSE requirements of M/s UPL and will strictly comply with HSE policy of M/s UPL. Further, contractor will arrange proper PPEs for all the crew working at site.
- 25- Contractor will submit list of the working personnel with Names, designation and their CNICs and also list of tools & equipment before mobilization as required for Gate Entry at M/s UPL.
- 26- One day prior intimation through M/s OGDCL will be required for M/s UPL gate entry with complete detail of material and manpower. Gate entry will be only allowed during daylight.
- 27- Boarding/lodging facility can be provided up to only ten (10) workers of the contractor at UPL and will be charged from the contractor as Rs. 2000/- per person per day for workers and Rs. 3200/- per person per day for senior staff. Boarding/lodging of extra manpower will be managed by contractor outside the UPL.
- 28- No cooking arrangement nor outsourced meal/catering services are allowed in UPL premises.

Hammad Ahmed JE (friech) PE & F

- 29- In case of any human injury/accident of the contractor's crew member(s) during the job, only general first aid will be provided to the affectee(s), whereas any other medical treatment would be the responsibility of the contractor. Further, OGDCL and UPL will not be liable for any claim/compensation etc.
- 30- Contractor should thoroughly review and understand the drawings, BOQ, TORs and SOW, and if finds any discrepancy/ambiguity then should communicate timely for clarification/correction before commencement of Job. OGDCL will not be responsible for any loss in terms of any re-work to be required by the contractor or due to job delay resulted in such case. All such rectification/re-work will be on the contractor's part.
- 31- The quote must include all federal / provincial taxes, levies, surcharges and applicable custom dues. OGDCL would not be liable for any custom clearance or payment of such dues in any manner whatsoever on these accounts.
- 32- Contractor will claim only actual quantity in the invoice for payment against the provided BOQ.

OGDCL Responsibilities:

- 1. OGDCL will facilitate material /manpower entry & exist at M/s UPL gate.
- 2. Water source for civil works will be provided to the contractor within UPL boundary. However, transportation arrangement from source to work site is in the contractor's scope.

Hammad Ahmed JE (Nech) PE & FD

SCOPE COMPLIANCE as part of evaluation (30 Marks)

#	Item (max. marks) for the BID	Bidder
		compli
		ance
1	Manually operated 05 tons overhead crane with 3.6 meters span travel.	
	Manufacturer LEEA certified documentation to be provided. (05)	
2	A-36 material supply for all structural plates and shapes to be	
	confirmed. (05)	
3	Machinery for project execution to be listed in Rs. 100/- Judicial Stamp	
	paper issued in the name of beneficiary. (05)	
4	Commissioning under Site Acceptance Test (SAT) would be actual filter	
	change activity / replacement. Bidder to accept this under OGDCL	
	Annual Turn Around (ATA) time line. (03)	
5	Shop fabrication drawings to be provided before site works start for	
	OGDCL approval in duplicate A0 hard copies and one digital AutoCAD	
	soft copy. (02)	
6	Company's HSEQ Engineer for site monitoring, CV to be attached. (02)	
7	Site Civil Engineer (PEC level PE) CV to be provided for OGDCL approval	}
	in the bid. (04)	
8	OGDCL QA/QC & Third Party Inspection (TPI) package compliance. (02)	
9	Detailed work schedule Bar Chart to be submitted for daily activities, as	
	project to be completed within 04 months after contract award. (02)	

The above table with 30 marks is part of para 09 Table under "General terms & Condition" making a total of 100 marks, minimum qualification marks is 70 out of 100. PEC C3 and turnover of RS 15 million per year as two mandatory requirements.



Mandatory Requirement

S. No.	DESCRIPTION	YES	NO
1	Has your firm been in litigation /blacklisted by OGDCL or any other firm? If yes, please provide details.		
2	NTN Certificate (Please attach NTN Certificate copy)		
3	GST Certificate (<i>Please attach GST Certificate copy</i>)		
4	Pakistan Engineering Council registration in relevant category (C3 or Above) (Please attach PEC registration certificate copy)		
5	Authorized contractor with Rs. 15 million annual turnover for the last 3 years. Project purchase orders to be shared.		

1.0 STATUS OF FIRM & GENERAL REQUIREMENTS

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Sr.	DESCRIPTION	DETAILS
1.1	Type of Firm	
	Private Ltd	
	> Partnership	
	> Proprietorship	
1.2	Average Annual Turnover in last three (3) years	
	 More than 50 Million 	
	 Between 40 to 50 Million 	
	> Between 25 to 40 Million	
	 Between 10 to 25 Million 	
	> Less than 10 Million	
	(Please provide audited financial reports of last three yea	rs)
1.3	Maximum Amount of Work Order Awarded	
	> More than 50 Million	
	 Between 40 to 50 Million 	
	> Between 25 to 40 Million	
	 Between 10 to 25 Million 	ł
	 Less than 10 Million 	
	(Please provide evidence)	\rangle



2. PAST EXPERIENCE

C

Sr.	DESCRIPTI	<u>ON</u>	DETAILS
	· ·	ience in Upstream E& P oil / gas industry (PEPCA or IOGP	· · · · · · · · · · · · · · · · · · ·
		rs companies ONLY) with SATISFACTION CERTIFICATES	
2.1	(with name,	contact person email, phone and postal address)	
<i>4</i> •• 1	>	Over 5 Years	
	>	Between 3 to 5 Years	
	>	Between 1 to 3 Years	}
	>	Less than 1 year	}
	(Please prov	ride evidence)	
	Work Done	of Similar nature in last 5 years for orders above Rs.50	}
) m	illion successfully completed	}
	×	More than 5 Projects	ł
2.2	>	4-5 works.	
	>	2 –4 works.	
	>	Less than 2	
	(Please prov	vide work orders)	
	Relevant Ex	cperience	
2.3	>	Supply & Installation	
		Supply only	}

Hammad Abmed JE (Nech) PE & FD

3. <u>HUMAN RESOURCE</u>

Sr.	DESCRIPTION
3.1	Engineer with PE PEC status
	□ More than 5
	D 4-5
[□ 2-3
	(Please provide evidence)
3.2	Engineer Experience (Average)
1	More than 10 years
	□ 5-9
	□ 3-4
	Less than 3
	(Please provide evidence)
	Number of Technicians
	□ More than 10
3.3	□ 5-9
0.0	
	🗇 Under 3
	(Please provide list of Technicians on company letter head)
	Technician's Installation Experience (Average)
	□ More than 15 years
3.4	
J.T	□ 4-9
	Less than 4
	(Please provide evidence)

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4. HSE COMPLIANCE

	Sr.		TAILS .
Ī	4.1	Compliance to HSE Booklets (Electrical and Construction, PPEs)	
{		□ Yes	
{	ĺ		
		(Please provide a signed and stamped copy of the mentioned HSE Booklets)	
	4.2	HSE Policy & Procedures	
		Copies of following provided (Y/N)	
		Singed HSE Policy (by CEO of the Contractor)	
		U Working at Height	
l l	ł	Dismantling	
	}	 Lifting Operations Confined Space Entry (Ducts Entry) 	
	}	 Power Actuated Equipment Safety 	
	}	 Welding, Cutting & Brazing 	
		PPE Procedure	
\frown	{	Electrical Lock out/Tag out system	
S. 1		□ Welfare for employees (Health, Drug abuse policy, Facilitation,	
)	Insurance etc)	
	1	Emergency Preparedness	
	}	Incident Reporting	
		Job Hazard Analysis	
	{	(Important: Please provide relevant documents/Guidelines/Work Instructions in Urdu	
	J	or English)	
	4.3	Does Company provide HSE Trainings on following:	
	ł	Job Specific Trainings:	
		Manual handling	
	{	Lifting Operations	
	{	Working at height	
	1	Permit to work	
	ļ	□ Welding, Cutting, Brazing	
~		Fork Lift Operations/ Hoist Crane Operations	
\mathbf{O}		D Apy Other (Place Specify)	
		Any Other (Please Specify)	
	{	Electrical Safety Training	
		Emergency Preparedness	
	}	□ Fire Extinguisher training	
	ł	□ First Aid	
	{	(Important: Please provide documentary evidence i.e. Attendance sheet, course contents,	
	L	external certificates, photographs, etc)	





OIL & GAS DEVELOPMENT COMPANY LTD.

PLATFORM WITH 5TON GANTRY CRANE AT UCH POWER PLANT

BILL OF QUANTITIES

1	1 21-MAY-2019 REVISED AS PER OGDCL COMMENTS		AZ	SFA	MAJ	
0	27-NOV-2018	ISSUED FOR REVIEW	AZ	SFA	MAJ	
REV.	EV. DATE DESCRIPTION OF ISSUE		ORIG.	СНК.	APPR.	
0	ES	OPTIMUM ENGINEERING SE Z-481, 1ST FLOOR, BLOCK 3, BAHADURABAD, KA Tel. (92-21) 34218282, 34931177, Fax: (92-21) 34931177 , Em	ARACHI, PAKISTAN.	engs.com		
Job No.		Document No.	Revision	Total Pag	Total Pages (inc front cover	
253-1		253-1-CIV-BOQ-001	1 3		3	

OIL & GAS DEVELOPMENT CO. LTD. PLATFORM WITH 5TON GANTRY CRANE - UCH POWER PLANT

BILL OF QUANTITIES

S.NO.	DESCRIPTION	NEW QTY	UNIT	REMARKS
1.0	5 TON GANTRY CRANE SUPPORTING STRUCTURE & PLATFORM			
	SUPPLY OF ALL MATERIALS AND CONSTRUCTION OF PLATFORM STRUCTURE AS PER SPECIFICATIONS, DRAWINGS AND TO THE ENTIRE SATISFACTION OF THE OWNER'S REPRESENTATIVE. THE WORK INCLUDES:			
i)	EXCAVATION: EXCAVATION FOR FOUNDATIONS TO THE REQUIRED DEPTH AS SHOWN ON DRAWINGS IN ALL KINDS OF SOIL DRY OR WET, HARD, AVERAGE OR SOFT INCLUDING DEWATERING AND SHORING IF REQUIRED AND ALL OPERATIONS OF BACKFILLING INCUDING FILLING OF EXCAVATED SOIL (IF EXCAVATED SOIL FOUND SUITABLE FOR BACKFILLING, AS RECOMMENDED BY GEO- TECHNICAL INVESTIGATION REPORT) IN 150mm THICK LAYERS WHEREVER REQUIRED WITHIN THE SPECIFIED DEPTH AND DISPOSAL OF EXCESS MATERIAL AT DESIGNATED PLACES. BACKFILL SHALL INCLUDE BREAKING CLODS, LEVELING, DRESSING, WATERING, CONSOLIDATION AND COMPACTION TO ATTAIN 95% DRY DENSITY AS PER ASTM D 1557. COMPLETE IN ALL RESPECTS AS PER DRAWINGS, SPECIFICATION AND AS DIRECTED BY THE OWNER'S REPRESENTATIVE / ENGINEER. (THIS ACTIVITY SHALL BE CARRIED OUT ON THE SAME / NEAR BY LOCATIONS)		CU.M	
ii)	C.C. 1:4:8 (SRC) PROVIDING AND LAYING CEMENT CONCRETE 1:4:8 IN FOUNDATION, FOR BLINDING OR UNDER FLOORS WHEREVER REQUIRED WITH APPROVED QUALITY 25mm AND DOWN SIZE STONE OR GRADED GRAVEL AND APPROVED QUALITY OF LOCAL RIVER SAND INCLUDING ALL FORMWORK RODING VIBRATING, LEVELING, COMPACTING, SPREADING AND CURING ETC. COMPLETE IN ALL RESPECTS AS PER DRAWINGS, SPECIFICATION AND AS DIRECTED BY THE OWNER'S REPRESENTATIVE / ENGINEER.	2	CU.M	
iii)	R.C.C. 3000 psi (SRC)			
	PROVIDING AND LAYING RCC OF SPECIFIED DESIGN MIX / STRENGTH AS MENTIONED IN THE DRAWING & RELATED B.O.Q. USING APPROVED QUALITY 20mm MAXIMUM CRUSHED GRADED STONES AND FINE AGGREGATE OF APPROVED QUALITY INCLUDING APPROVED FORMWORK AND ITS REMOVAL, ALL OPERATIONS OF VIBRATING, LEVELING, COMPACTING, SPREADING, CURING AND TESTING ETC. COMPLETE IN ALL RESPECTS AS PER DRAWINGS, SPECIFICATION AND AS DIRECTED BY THE OWNER'S REPRESENTATIVE / ENGINEER.	11	CU.M	
iv)	STRUCTURAL STEEL (A-36)			
	SUPPLYING AND FIXING JOISTS, CHANNEL, ANGLE, TEE SECTIONS, GUARD BARS, RAILINGS, LADDERS, BRACKETS, HOOKS, HOLD FASTS, PIPE SUPPORTS PLATES ROOF TRUSSES, BEAMS, PURLINS ETC., ASSEMBLING BY WELDING OR WITH THE USE OF BOLTS, NUTS, RIVETS, WASHERS ETC., AND ERECTION / FIXING IN POSITION INCLUDING MAKING GOOD THE DISTURBED SURFACES WITH SURFACE PREPARATION BY SAND BLASTING TO SA 2.5, SUPPLY & APPLICATION OF 2 COATS EPOXY PRIMER & 2 COATS OF EPOXY FINISHAS PER MANUFACTURER'S RECOMMENDATIONS (COLOUR SCHEME TO BE PROVIDED BY OWNER'S REPRESENTATIVE). COMPLETE IN ALL RESPECTS AS PER DRAWINGS, SPECIFICATION AND AS DIRECTED BY THE OWNER'S REPRESENTATIVE / ENGINEER.		TONS	RATES FOR STRUCTURAL STEEL SHALL BE INCLUSIVE OF SURFACE PREPARATION BY SAND BLASTING TO SA 2.5, SUPPLY & APPLICATION OF PAINT. APPROVED BRANDS ARE ICI, BERGER, NIPPON, JOTUN, KANSAI, CARBOLINE OR AN EQUIVALENT APPROVED BY THE OWNER
v)	ANCHOR BOLTS (A-307) SUPPLYING AND FIXING ANCHOR BOLTS WITH HEXAGON, SQUARE, CUP OR CHEESE HEADS, SCREWED ONE OR BOTH END, OR ONE END ENLARGED OR JAGGED OR LEWISED, EACH WITH ONE WASHER AND TWO HEXAGON OR SQUARE NUT. COMPLETE IN ALL RESPECTS AS PER DRAWINGS, SPECIFICATION AND AS DIRECTED BY THE OWNER'S REPRESENTATIVE / ENGINEER.	30	КG	

OIL & GAS DEVELOPMENT CO. LTD. PLATFORM WITH 5TON GANTRY CRANE - UCH POWER PLANT

BILL OF QUANTITIES

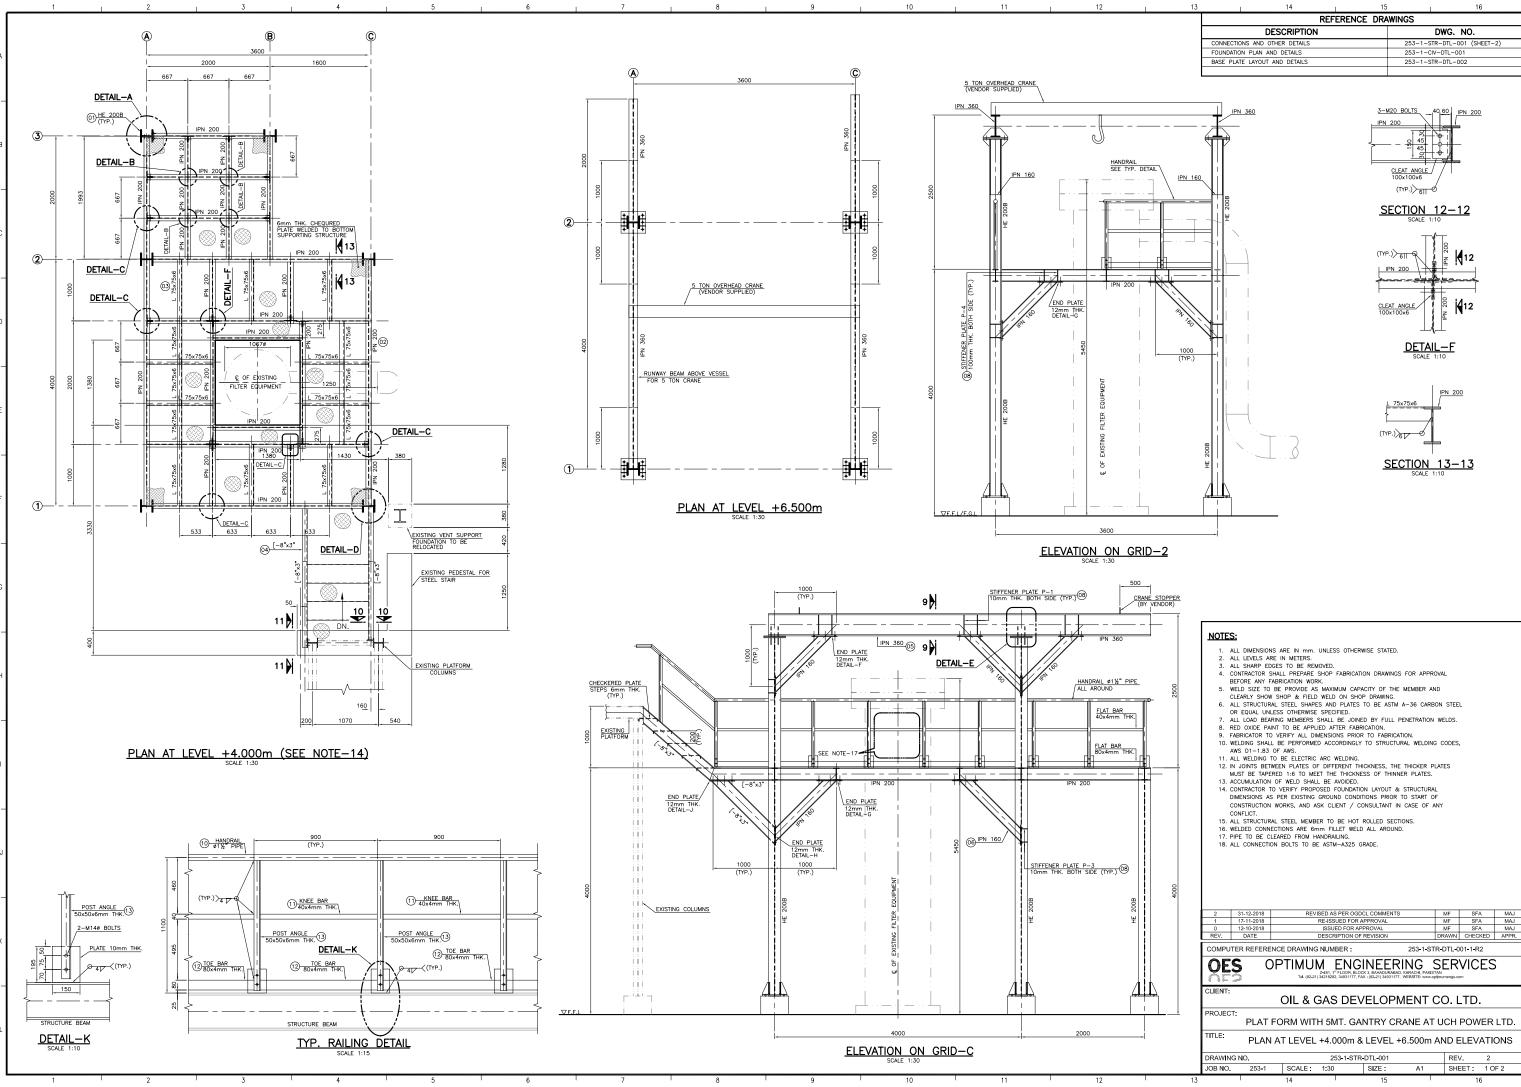
S.NO.	DESCRIPTION	NEW QTY	UNIT		REMARKS
,	BITUMEN COATING PROVIDING AND APPLYING 03 COATS OF BITUMEN GRADE 10 / 20 TO ACHIEVE 1200 MICRONS THICKNESS WITH 01 COAT OF PRIMER ON CONCRETE SURFACES EXPOSED TO EARTH. COMPLETE IN ALL RESPECTS AS PER DRAWINGS, SPECIFICATION AND AS DIRECTED BY THE OWNER'S REPRESENTATIVE / ENGINEER.		SQ.M		
vii)	STEEL REINFORCEMENT (60,000 PSI) PROVIDING AND LAYING DEFORMED STEEL REINFORCEMENT INCLUDING THE COST OF STRAIGHTENING, CUTTING, BENDING, BINDING, WASTAGE AND SUCH OVERLAPS AS ARE NOT SHOWN OVER THE DRAWINGS, PLACING IN POSITION ON M.S, CHAIRS, TYING WITH BINDING WIRES, ETC., IN ALL KINDS OF RCC WORK INCLUDING THE COST OF 18 GAUGE BINDING WIRES, CHAIRS, SPACERS ETC. COMPLETE IN ALL RESPECTS AS PER DRAWINGS, SPECIFICATION AND AS DIRECTED BY THE OWNER'S REPRESENTATIVE / ENGINEER.		TONS		
2.0	5 TON CAPACITY GANTRY CRANE SUPPLY, ERECTION, INSTALLATION, TESTING & COMMISSIONING OF 5 TONNES CAPACITY, OVERHEAD TRAVELLING CRANE. CRANE SHALL BE MECHANICAL TYPE, SINGLE GIRDER, TOP SLIDING, APPROX. 3.6 M SPAN, SUITABLE FOR INSTALLATION ON STEEL STRUCTURE PLATFORM AS SHOWN ON DWG. NO. 253-1-STR-DTL-001.		UNIT		COMPLETE TECHNICAL DETAILS OF THE CRANE SHALL BE SUBMITTED WITH THE BID.
				TOTAL (Rs.)	

(RUPEES

ONLY)


COMPANY SEAL

BIDDER'S SIGNATURE



13	1	14	15	16
		REF	ERENCE DRAWINGS	
	[ESCRIPTION		DWG. NO.
[CONNECTIONS AND	OTHER DETAILS	253	-1-STR-DTL-001 (SHEET-2)
	FOUNDATION PLAN	ND DETAILS	253	-1-CIV-DTL-001
	BASE PLATE LAYOUT	AND DETAILS	253	-1-STR-DTL-002
-				

		ARE IN mm. UNLESS OTHERWISE STATED.			
	ALL LEVELS ARE	IN METERS. S TO BE REMOVED.			
		LL PREPARE SHOP FABRICATION DRAWINGS FOR A			
	BEFORE ANY FAB		11100112		
5.	WELD SIZE TO BE	PROVIDE AS MAXIMUM CAPACITY OF THE MEMBE	R AND		
		HOP & FIELD WELD ON SHOP DRAWING.			
6.		STEEL SHAPES AND PLATES TO BE ASTM A-36	CARBON STEE	EL	
-		S OTHERWISE SPECIFIED.	TION		
		G MEMBERS SHALL BE JOINED BY FULL PENETRA TO BE APPLIED AFTER FABRICATION.	TION WELDS.		
		ERIFY ALL DIMENSIONS PRIOR TO FABRICATION.			
		BE PERFORMED ACCORDINGLY TO STRUCTURAL WE	LDING CODES	s.	
	AWS D1-1.83 OF	AWS.			
		BE ELECTRIC ARC WELDING.			
12.		IN PLATES OF DIFFERENT THICKNESS, THE THICK			
17		D 1:6 TO MEET THE THICKNESS OF THINNER PLA	IES.		
		F WELD SHALL BE AVOIDED. VERIFY PROPOSED FOUNDATION LAYOUT & STRUC			
14.		ER EXISTING GROUND CONDITIONS PRIOR TO STA			
		ORKS, AND ASK CLIENT / CONSULTANT IN CASE			
	CONFLICT.				
15.		STEEL MEMBER TO BE HOT ROLLED SECTIONS.			
16.		IONS ARE 6mm FILLET WELD ALL AROUND.			
17.	WELDED CONNECT PIPE TO BE CLEA	IONS ARE 6mm FILLET WELD ALL AROUND. RED FROM HANDRAILING.			
17.	WELDED CONNECT PIPE TO BE CLEA	IONS ARE 6mm FILLET WELD ALL AROUND.			
17.	WELDED CONNECT PIPE TO BE CLEA	IONS ARE 6mm FILLET WELD ALL AROUND. RED FROM HANDRAILING.			
17. 18. 2	WELDED CONNECT PIPE TO BE CLEA ALL CONNECTION	IONS ARE 6mm FILLET WELD ALL AROUND. RED FROM HANDRAILING. BOLTS TO BE ASTM-A325 GRADE. REVISED AS PER OGDCL COMMENTS	MF	SFA	
17. 18. 2 1	WELDED CONNECT PIPE TO BE CLEA ALL CONNECTION 31-12-2018 17-11-2018	IONS ARE 6mm FILLET WELD ALL AROUND. RED FROM HANDRAILING. BOLTS TO BE ASTM-A325 GRADE. REVISED AS PER OGDCL COMMENTS REVISED AS PER OGDCL COMMENTS	MF	SFA	M
17. 18. 2 1 0	WELDED CONNECT PIPE TO BE CLEA ALL CONNECTION 31-12-2018 17-11-2018 12-10-2018	IONS ARE 6mm FILLET WELD ALL AROUND. RED FROM HANDRAILING. BOLTS TO BE ASTM-A325 GRADE. REVISED AS PER OGDCL COMMENTS RE-ISSUED FOR APPROVAL ISSUED FOR APPROVAL	MF	SFA SFA	M
17. 18. 2 1 0 REV.	WELDED CONNECT PIPE TO BE CLEA ALL CONNECTION 31-12-2018 17-11-2018 12-10-2018 DATE	IONS ARE 6mm FILLET WELD ALL AROUND. RED FROM HANDRAILING. BOLTS TO BE ASTM-A325 GRADE. REVISED AS PER OGDCL COMMENTS RE-ISSUED FOR APPROVAL ISSUED FOR APPROVAL DESCRIPTION OF REVISION	MF MF DRAWN	SFA SFA CHECKED	M
17. 18. 2 1 0 REV.	WELDED CONNECT PIPE TO BE CLEA ALL CONNECTION 31-12-2018 17-11-2018 12-10-2018 DATE JTER REFERENCE	IONS ARE 6mm FILLET WELD ALL AROUND. RED FROM HANDRAILING. BOLTS TO BE ASTM-A325 GRADE. REVISED AS PER OGDCL COMMENTS RE-ISSUED FOR APPROVAL ISSUED FOR APPROVAL DESCRIPTION OF REVISION 25 DRAWING NUMBER : 253	MF MF DRAWN 1-STR-DTL-0	SFA SFA CHECKED 001-1-R2	M M AP
17. 18. 2 1 0 REV.	WELDED CONNECT PIPE TO BE CLEA ALL CONNECTION 31-12-2018 17-11-2018 12-10-2018 DATE JTER REFERENCE	INIS ARE 6mm FILLET WELD ALL AROUND. RED FROM HANDRAILING. BOLTS TO BE ASTM-A325 GRADE. REVISED AS PER OGDCL COMMENTS RE-ISSUED FOR APPROVAL ISSUED FOR APPROVAL DESCRIPTION OF REVISION 253-	MF DRAWN 1-STR-DTL-C	SFA SFA CHECKED 001-1-R2	M M AP
17. 18. 2 1 0 REV. COMPL	31-12-2018 17-12-2018 17-11-2018 DATE	IONS ARE 6mm FILLET WELD ALL AROUND. RED FROM HANDRAILING. BOLTS TO BE ASTM-A325 GRADE. REVISED AS PER OGDCL COMMENTS RE-ISSUED FOR APPROVAL ISSUED FOR APPROVAL DESCRIPTION OF REVISION 25 DRAWING NUMBER : 253	MF DRAWN 1-STR-DTL-C	SFA SFA CHECKED 001-1-R2	M M AP
17. 18. 2 1 0 REV. COMPL	31-12-2018 17-11-2018 17-11-2018 17-11-2018 12-10-2018 DATE JTER REFERENCE S	INDS ARE 6mm FILLET WELD ALL AROUND. RED FROM HANDRAILING. BOLTS TO BE ASTM-A325 GRADE. REVISED AS PER OGDCL COMMENTS RE-ISSUED FOR APPROVAL ISSUED FOR APPROVAL DESCRIPTION OF REVISION E DRAWING NUMBER : 253- COMMENSION OF REVISION E DRAWING NUMBER : 253- COMMENSION OF REVISION E DRAWING NUMBER : 253- COMMENSION OF REVISION 2481, 1 ^{ref} LOOR BLOOK 3, BMMOUTRABD, KARACH TH. (8241) 3418322, 34831177, FAX: (8242) 34931177, WEBSTER	MF MF DRAWN 1-STR-DTL-C SER PAKISTAN www.optimumengs.c	SFA SFA CHECKED 001-1-R2 VICES	M M AP
17. 18. 1 0 REV. COMPL	31-12-2018 17-11-2018 17-11-2018 17-11-2018 17-11-2018 DATE JTER REFERENCE S	INIS ARE 6mm FILLET WELD ALL AROUND. RED FROM HANDRAILING. BOLTS TO BE ASTM-A325 GRADE. REVISED AS PER OGDCL COMMENTS RE-ISSUED FOR APPROVAL ISSUED FOR APPROVAL DESCRIPTION OF REVISION 253-	MF MF DRAWN 1-STR-DTL-C SER PAKISTAN www.optimumengs.c	SFA SFA CHECKED 001-1-R2 VICES	M AP
17. 18. 1 0 REV. COMPL	31-12-2018 17-11-2018 17-11-2018 17-11-2018 17-12-2018 DATE	INDS ARE 6mm FILLET WELD ALL AROUND. RED FROM HANDRAILING. BOLTS TO BE ASTM-A325 GRADE. REVISED AS PER OGDCL COMMENTS RE-ISSUED FOR APPROVAL ISSUED FOR APPROVAL DESCRIPTION OF REVISION E DRAWING NUMBER : 253- COMMENSION OF REVISION E DRAWING NUMBER : 253- COMMENSION OF REVISION E DRAWING NUMBER : 253- COMMENSION OF REVISION 2481, 1 ^{ref} LOOR BLOOK 3, BMMOUTRABD, KARACH TH. (8241) 3418322, 34831177, FAX: (8242) 34931177, WEBSTER	MF MF DRAWN 1-STR-DTL- C SSER PAKISTAN www.optimumenge.c	SFA SFA CHECKED D01-1-R2 VICES	
17. 18. 2 1 0 REV. COMPL	31-12-2018 17-11-2018 17-11-2018 17-11-2018 17-11-2018 DATE JTER REFERENCE SOF PLAT FC	INIS ARE 6mm FILLET WELD ALL AROUND. RED FROM HANDRAILING. BOLTS TO BE ASTM-A325 GRADE. REVISED AS PER OGDCL COMMENTS RE-ISSUED FOR APPROVAL ISSUED FOR APPROVAL DESCRIPTION OF REVISION DESCRIPTION OF REVISION EDRAWING NUMBER : 253- CTIMUM ENGINEERING 2481, 97 HOOR BEOCK 3 BANKOURABD KARACH TAL (1921) 341892, 3493177, 743: (1924) 3493177, WESSTER OIL & GAS DEVELOPMEN DRM WITH 5MT. GANTRY CRANE	MF MF DRAWN 1-STR-DTL- SER PARISTAN www.opthumenge.c T CO.I	SFA SFA CHECKED 001-1-R2 VICES	M. API
17. 18. 2 1 0 REV. COMPL	31-12-2018 17-11-2018 17-11-2018 17-11-2018 17-11-2018 DATE JTER REFERENCE SOF PLAT FC	IONS ARE 6mm FILLET WELD ALL AROUND. RED FROM HANDRAILING. BOLTS TO BE ASTM-A325 GRADE. REVISED AS PER OGDCL COMMENTS RE-ISSUED FOR APPROVAL ISSUED FOR APPROVAL DESCRIPTION OF REVISION DESCRIPTION OF REVISION DESC	MF MF DRAWN 1-STR-DTL- SER PARISTAN www.opthumenge.c T CO.I	SFA SFA CHECKED 001-1-R2 VICES	
17. 18. 2 1 0 REV.	31-12-2018 17-12-2018 17-11-2018 17-11-2018 17-11-2018 DATE	INIS ARE 6mm FILLET WELD ALL AROUND. RED FROM HANDRAILING. BOLTS TO BE ASTM-A325 GRADE. REVISED AS PER OGDCL COMMENTS RE-ISSUED FOR APPROVAL ISSUED FOR APPROVAL DESCRIPTION OF REVISION DESCRIPTION OF REVISION EDRAWING NUMBER : 253- CTIMUM ENGINEERING 2481, 97 HOOR BEOCK 3 BANKOURABD KARACH TAL (1921) 341892, 3493177, 743: (1924) 3493177, WESSTER OIL & GAS DEVELOPMEN DRM WITH 5MT. GANTRY CRANE	MF MF DRAWN 1-STR-DTL-(SERIETAN WWW.optimuregic.c T CO. I AT UCH Dm AND F RE	SFA SFA CHECKED D01-1-R2 VICES TTD. POWER ELEVATI	M. API

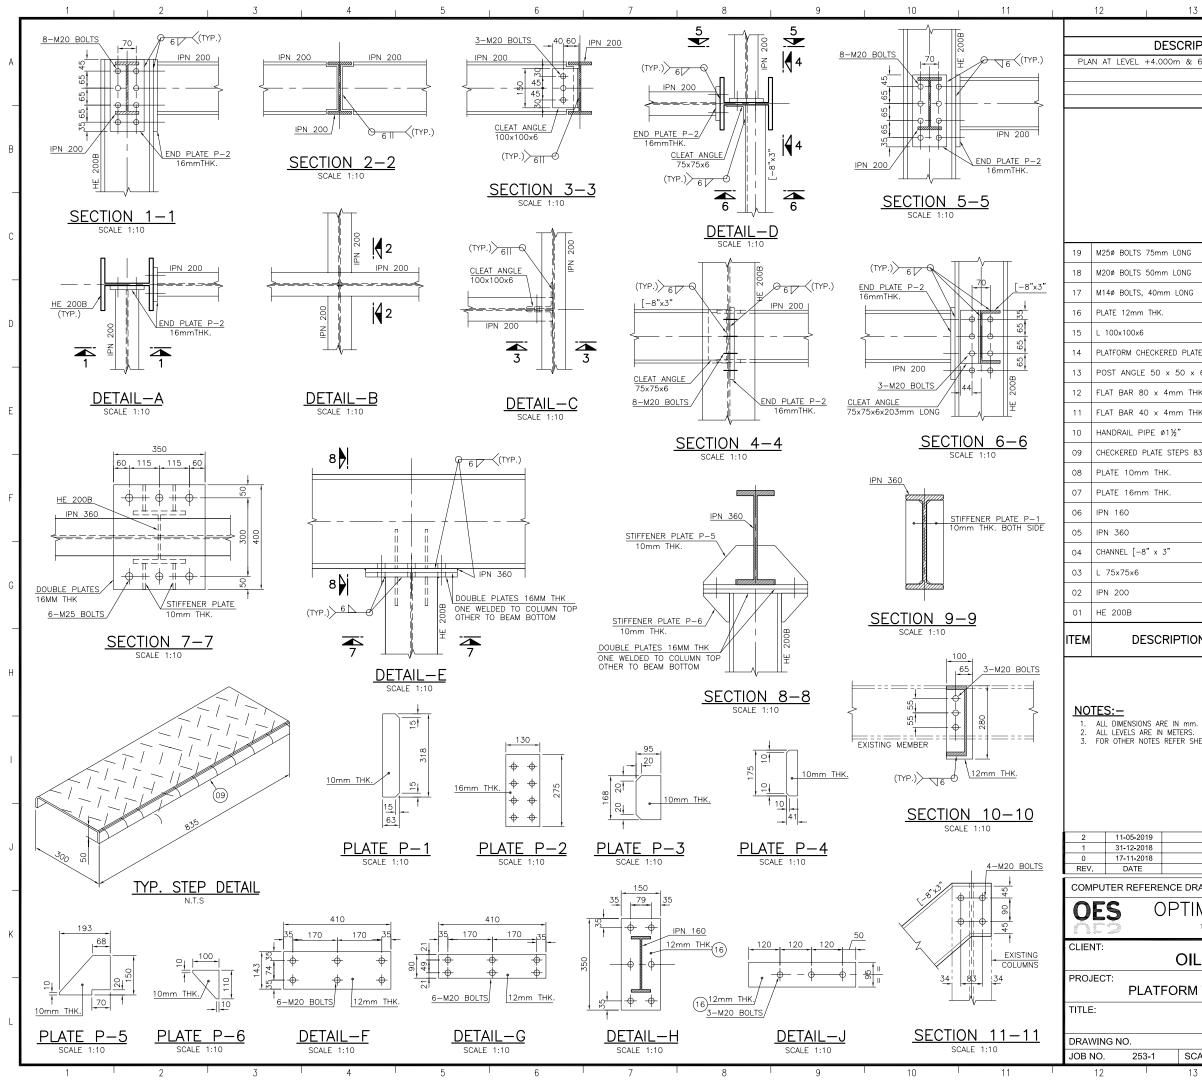

<u>/2</u> \	(5.5 m ²)	ASIM A-36	94.2	Kg/m ⁻	518	
	8 R.M	ASTM A-36	9.2	Kg/m	74	D
ED PLATE 6mm THK.	20m²	ASTM A-36	49.74	Kg/m²	995	
< 50 x 6mm THK.	30 R.M	ASTM A-36	4.47	Kg/m	134	-
mm THK.	22 R.M	ASTM A-36	2.512	2 Kg/m	55	
mm THK.	25 R.M	ASTM A-36	1.256	∂ Kg/m	31	Е
1½"	25 R.M	API-5L Gr.B	4.05	Kg/m	101	
STEPS 835x400x6 THK.	5	ASTM A-36	15.7	Kg/Pc.	79	F
, 	3.5m²	ASTM A-36	78.5	Kg/m²	275	
, 	2m²	ASTM A-36	125.6	∂ Kg/m	251	F
	16 R.M	ASTM A-36	17.9	Kg/m	286	
	12 R.M	ASTM A-36	76.1	Kg/m	913	
"	9 R.M	ASTM A-36	23.85	ō Kg/m	215	-
	16 R.M	ASTM A-36	6.85	Kg/Pc.	110	
	49 R.M	ASTM A-36	26.2	Kg/m	1284	G
	31 R.M	ASTM A-36	61.3	Kg/m	1900	
		MATERIAL	WT.,	/UNIT	TOTAL(KG)	╞
RIPTION	QTY.	MATERIAL	TOTAL	WT.KG.	7221	
METERS. EFER SHEET-1.						
REVISED	WHERE IN	DICATED	N	IF SFA	A MAJ	
REVISED AS		COMMENTS	N	IF SFA	A MAJ	J
	PTION OF R			AWN CHEC		
ICE DRAWING NUME	BER :	253	-1-STR-D	TL-001-2-R	2	-
PTIMUM ENGINEERING SERVICES Tel. (92-21) 34218282, 34931177, FX (192-21) 34931177, WEBSITE: www.opdimumengs.com						
OIL & GAS DEVELOPMENT CO. LTD.						ĸ
ORM WITH 5M	T. GAN	TRY CRANE	AT UC	CH POW	ER LTD.	_
CONNEC	TIONS	AND OTHEF	R DETA	AILS		L
	3-1-STR-D)TL-001		REV.	2	
		SIZE : A	2	SHEET :	2 OF 2	
13	14		15	I	16	

REFERENC	E DRA	WINGS		
SCRIPTION		DWG.	NO.	
m & 6.500m AND ELEVATIO	٧S	253-1-STR-DTL-C	001 (SHEET-1)	A
				Γ.

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A-307

A-307

A-307

ASTM A-36

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94.2 Kg/m²

15

14

24 NOS.

400 NOS

52 NO

2 5.5 m²


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N METERS.						
TO BE REMOVED. L PREPARE SHOP FABRICATION DRAV						
	TOR AFFROVAL BEFORE ANT					
PROVIDE AS MAXIMUM CAPACITY OF	MEMBER AND CLEARLY SHOW	н				
LD ON SHOP DRAWING. STEEL SHAPES AND PLATES TO BE ASTM A-36 CARBON STEEL OR EQUAL						
SIEEL SHAPES AND PLAIES TO BE ASIM A-36 CARBON SIEEL OR EQUAL E SPECIFIED.						
G MEMBERS SHALL BE JOINED BY FULL PENETRATION WELDS.						
TO BE APPLIED AFTER FABRICATION.						
RIFY ALL DIMENSIONS PRIOR TO FABRICATION.						
E PERFORMED ACCORDINGLY TO STR	AL WELDING CODES,					
AWS. BE ELECTRIC ARC WELDING.						
N PLATES OF DIFFERENT THICKNESS	THICKER PLATES MUST BE					
MEET THE THICKNESS OF THINNER P						
WELD SHALL BE AVOIDED.		-				
REVISED WHERE INDICAT	MF SFA MAJ	_				
REVISED WHERE INDICAT		J				
ISSUED FOR REVIEW / APPR	MF SFA MAJ	٦°				
DESCRIPTION OF REVISIO	DRAWN CHECKED APPR					
CE DRAWING NUMBER :	253-1-STR-DTL-002-R2					
	ING SERVICES	_				
Z-481, 1 ^{5™} FLOOR, BLOCK 3, BAHA						
Tel. (92-21) 34218282, 34931177, FAX : (92-21)	WEBSITE: www.optimumengs.com	к				
OIL & GAS DEVEL	IENT CO. LTD.					
DRM WITH 5MT. GANTRY	ANE AT UCH POWER LTD.					
BASE PLATE LAYO						
BASE FLATE LATC	IND DETAILS	L				
253-1-STR-DTL-0	REV. 2					
SCALE: 1:30 SIZE	A2 SHEET : 1 OF 1	1				
13 14						
	15 16					
	15 16					

FIUN		MATERIAL	TOTAL WT.KG.	245	-
IPTION	QTY.	MATERIAL	WT./UNIT	TOTAL(KG)	
< 450 x 20mm THK.	06 NOS.	ASTM A-36	157 Kg/m²	191	E
k 12mm THK.	48 NOS.	ASTM A-36	94.2 Kg/m²	54	_
	2				

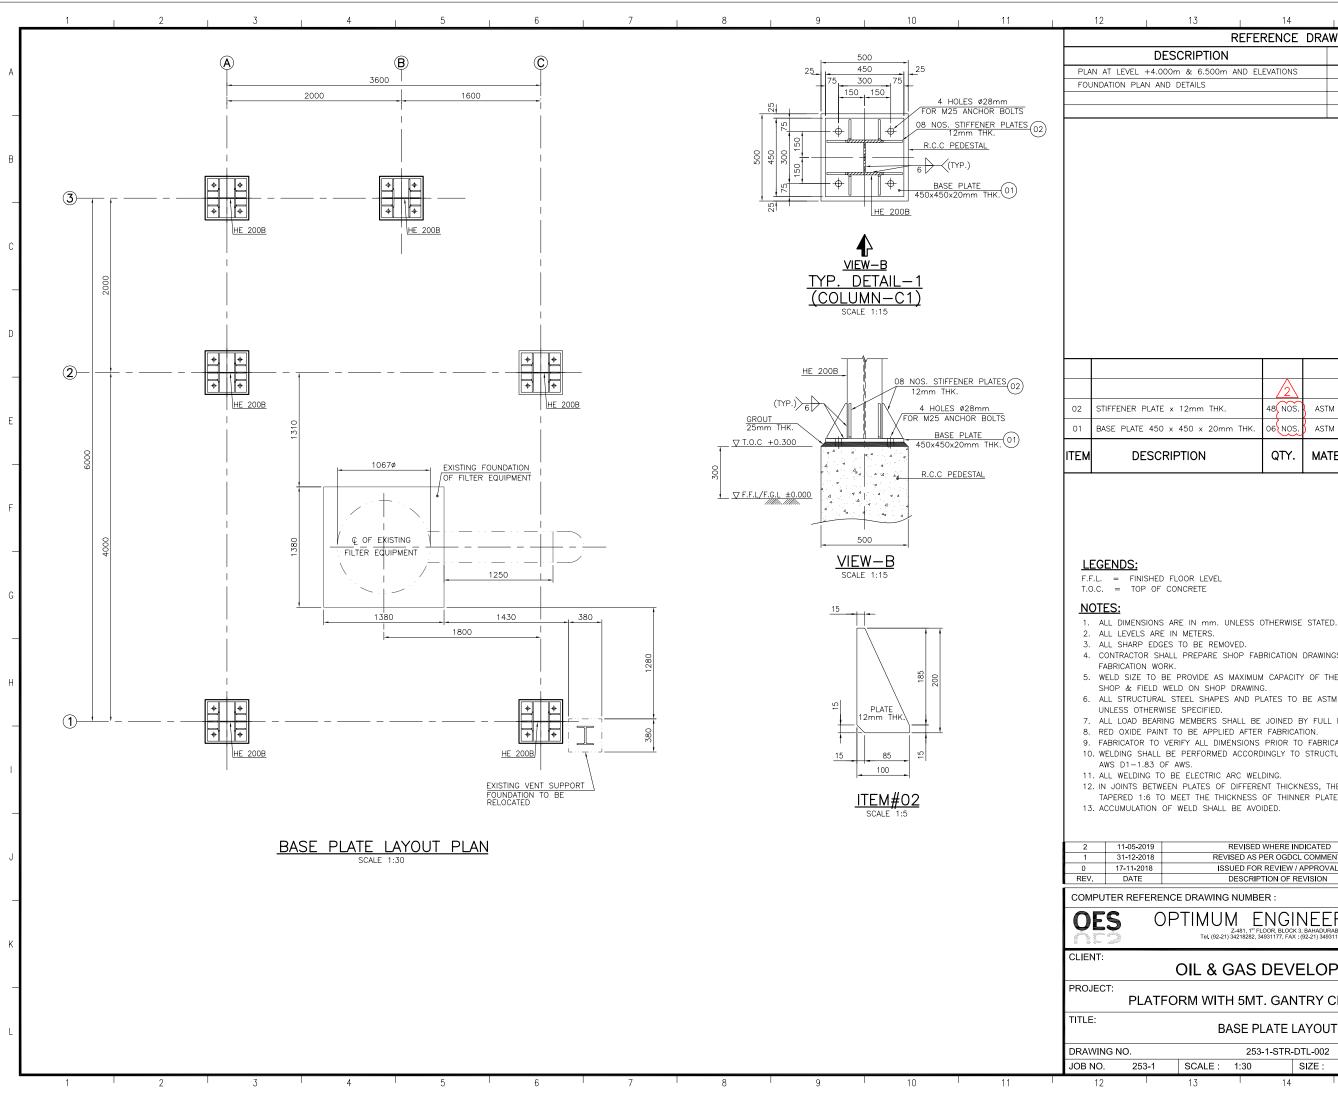13 14	15	16
REFERENCE DI	RAWINGS	
SCRIPTION	DWG.	NO.
0m & 6.500m AND ELEVATIONS	253-1-STR-DTL-0	01 (SHEET-1 & 2)
DETAILS	253-1-CIV-DTL-00)1